


(4)(2)∠ RISE 30x30 SA DUCT UP THRU ROOF. 8'-0" MIN. -- RISE 30x30 SA DUCT UP THRU ROOF. 4 2 CORRIDOR 209 CORRIDOR 221 4 2 -

252

POOL AREA MECHNICAL PLAN

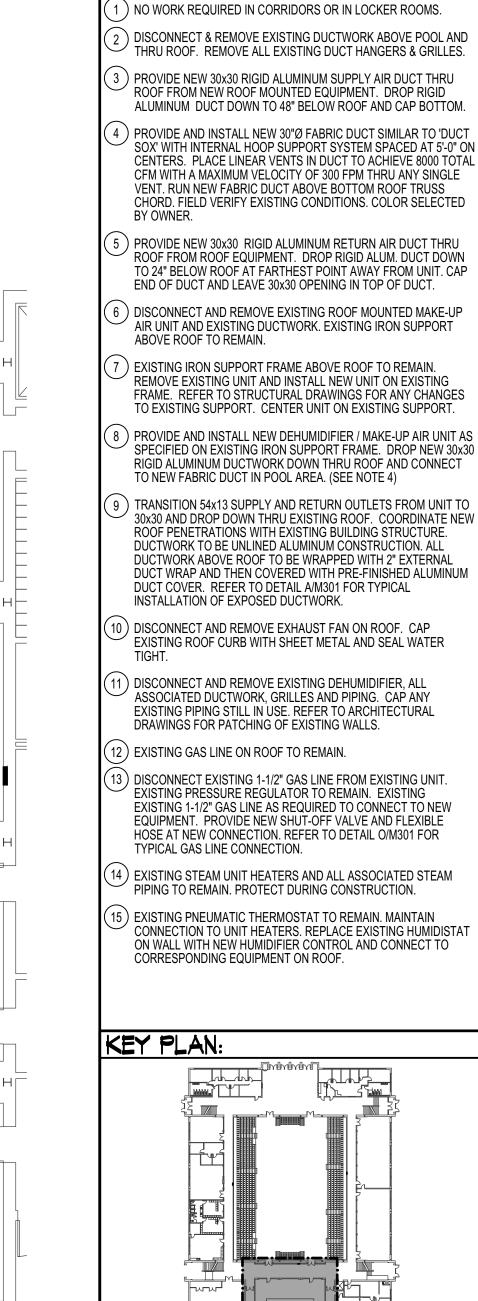

PLAN NOTES:

/AC UPGRAIUNIVERSITY

5 Y M 5 STA 1922

SHEET TITLE:

**POOL AREA** MECHANICAL **PLANS** 

Engineered Systems Contractor shall verify all dimensions & conditions shown or implied **Associates** 1355 EAST CENTER POCATELLO, IDAHO 83201

DRAWING SCALE APPLIES TO 22" X 34" SHEET SIZE

BLD2009-00063 COMPLIANCE This approval shall not be construed to be an approval of any violation of, or variance from, Idaho's adopted codes, standards,

laws or rules applicable to this project. SEPARATE BUILDING PERMIT REQUIRED FOR CONSTRUCTION

M JENSEN CHECKED


D SUDWEEKS NUMBER: 18467

M104 12

UPPER POOL AREA MECHANICAL PLAN SCALE: 1/8" = 1'-0"

KEY PLAN:

ORIGINAL DRAWING SIGNED BY: DWAYNE C. SUDWEEKS DATE ORIGINAL SIGNED: Feb 16, 2021 ORIGINAL ON FILE AT ENGINEERED SYSTEMS ASSOCIATES 1355 EAST CENTER, POCATELLO, IDAHO 83201

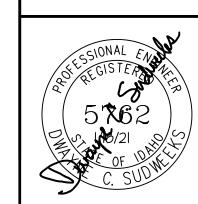



(208) 233-0501 (208) 233-0529 EMAIL: esa@engsystems.com ESA JOB NUMBER: 18050

PROJECT DATE: FEBRUARY 2021

SCALE: 1/8" = 1'-0"